

AUTOCAD



REVIT



Gráfica_Digital

CAD_08 - Abrir um arquivo de AutoCad .dwg no Revit

Este tutorial foi elaborado pela equipe de monitores de DIG de 2015-2

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Architecture Structure Systems **Insert** Annotate Analyze Massing & Site Collaborate View Manage Add-Ins Modify

Modify Link Revit Link IFC Link CAD DWF Markup Decal Point Cloud Manage Links Import CAD Import gbXML Import from File Image Manage Images Load Family Load as Group

Select ▼ Link Import Load from Library

Search Autodesk Seek
Find and download building product models, drawings, and specs
Autodesk Seek

Properties

Floor Plan

Floor Plan: Level 1 Edit Type

Graphics

View Scale 1:100
Scale Value 1: 100
Display Model Normal
Detail Level Coarse
Parts Visibility Show Original
Visibility/Graph... Edit...
Graphic Displa... Edit...
Underlay None
Underlay Orien... Plan
Orientation Project North
Wall Join Display Clean all wall...
Discipline Architectural
Show Hidden L... By Discipline
Color Scheme Background

Properties help Apply

Project Browser - Project1

Views (all)

- Floor Plans
 - Level 1
 - Level 2
 - Site
- Ceiling Plans
 - Level 1
 - Level 2
- Elevations (Building Elevation)
 - East
 - North
 - South
 - West
- Legends
- Schedules/Quantities
- Sheets (all)
- Families
- Groups
- Revit Links

Após abrir o Revit, ir para a opção **INSERIR**

1:100

Click to select, TAB for alternates, CTRL adds, SHIFT unselects.

Main Model

18:18

POR
PTB2
22/11/2015

Architecture Structure Systems Insert Annotate Analyze Massing & Site Collaborate View Manage Add-Ins Modify

Modify Link Revit Link IFC Link CAD Link CAD Link CAD

Select

Link CAD
Links a CAD file to the current Revit project.

Search Autodesk Seek
Find and download building product models, drawings, and specs

Autodesk Seek

Load from Library

Load as Family

Load Family

Manage Images

Manage Images

Properties

Floor Plan

Press F1 for more help

Linking is similar to having an xref in AutoCAD. When the original linked file changes, these changes are reflected (if possible) in the file when you reload the project.

Floor Plan: Level 1 Edit Type

Graphics

View Scale 1:100

Scale Value 1: 100

Display Model Normal

Detail Level Coarse

Parts Visibility Show Original

Visibility/Graph... Edit...

Graphic Displa... Edit...

Underlay None

Underlay Orien... Plan

Orientation Project North

Wall Join Display Clean all wall...

Discipline Architectural

Show Hidden L... By Discipline


Color Scheme ... Background

Properties help Apply

Project Browser - Project1

- Views (all)
- Floor Plans
 - Level 1
 - Level 2
 - Site
- Ceiling Plans
 - Level 1
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Usar a opção **LINK CAD**

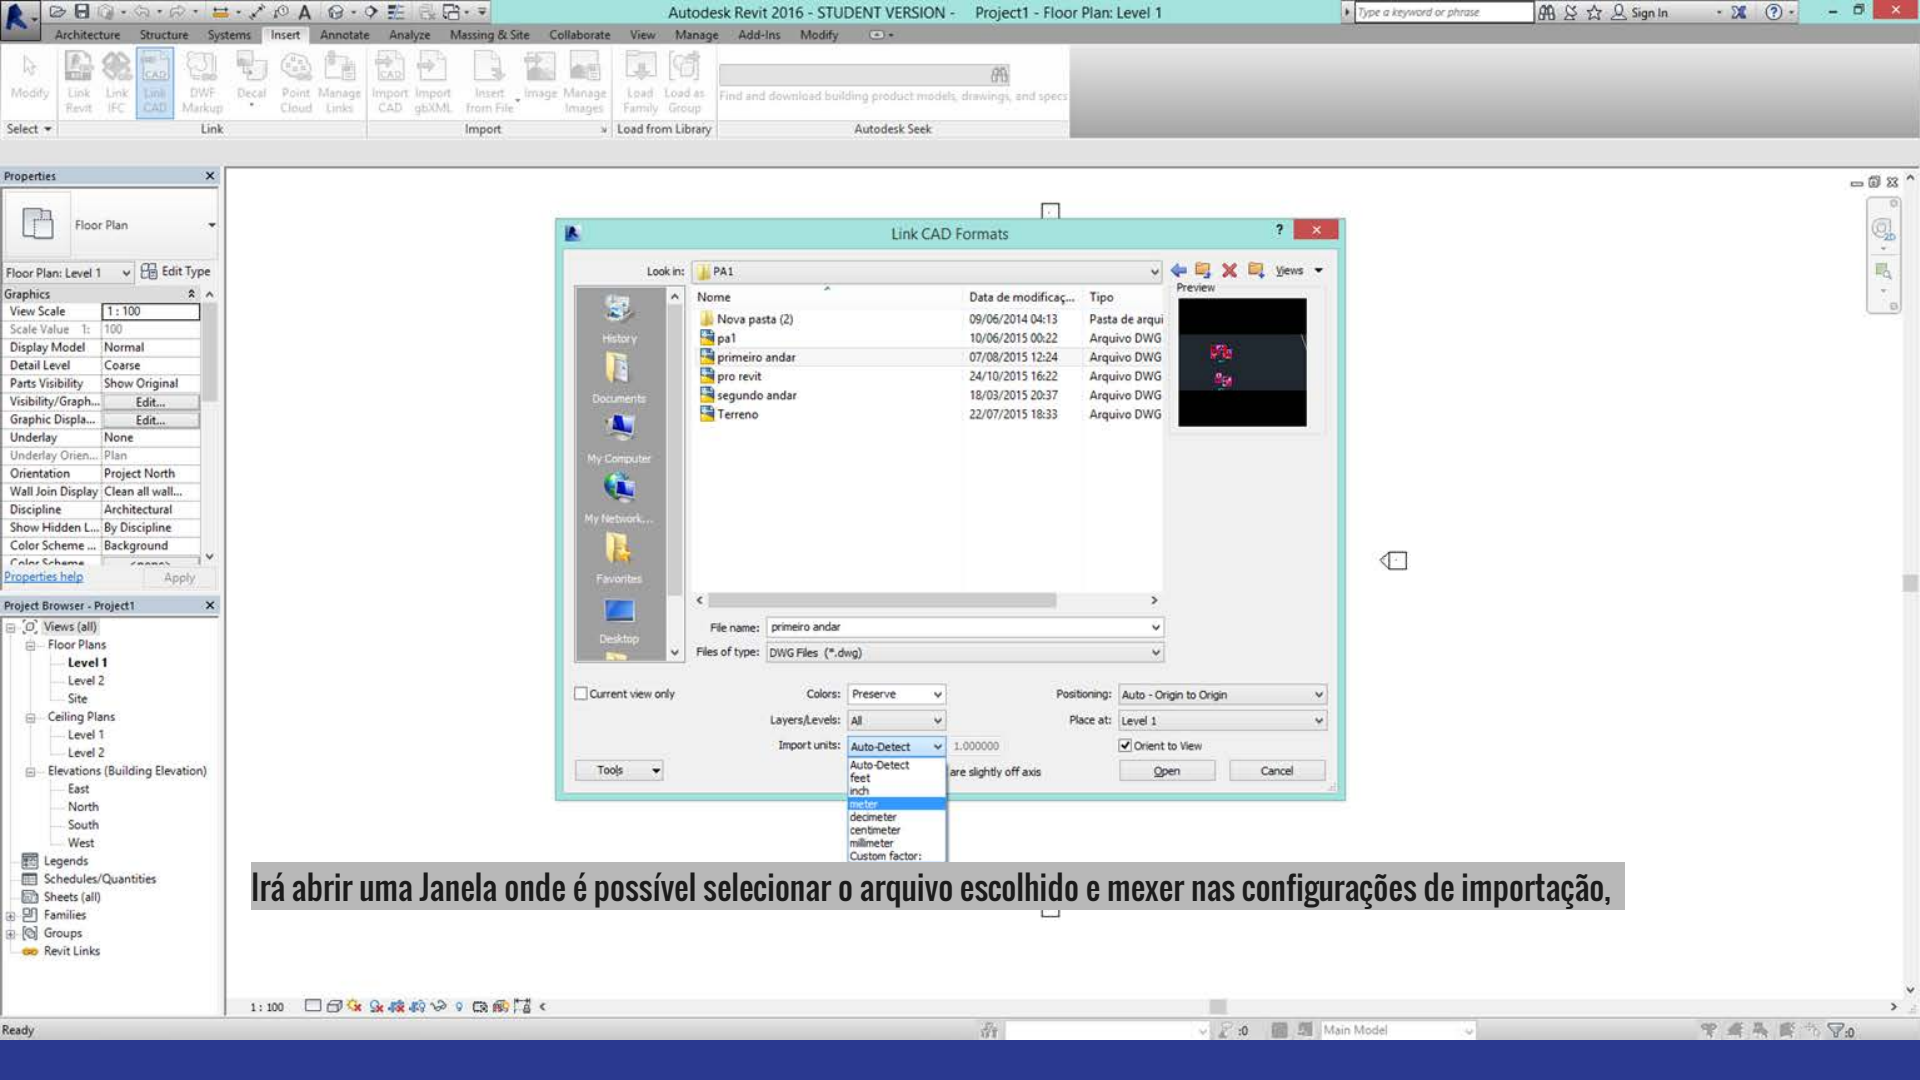

Irá abrir uma Janela onde é possível selecionar o arquivo escolhido e mexer nas configurações de importação,

Properties

Floor Plan

Floor Plan: Level 1 Edit Type

Graphics

View Scale 1:100

Scale Value 1: 100

Display Model Normal

Detail Level Coarse

Parts Visibility Show Original

Visibility/Graph... Edit...

Graphic Displa... Edit...

Underlay None

Underlay Orient... Plan

Orientation Project North

Wall Join Display Clean all wall...

Discipline Architectural

Show Hidden L... By Discipline

Color Scheme Background

Properties help Apply

Project Browser - Project1

Views (all)

Floor Plans

Level 1

Level 2

Site

Ceiling Plans

Level 1

Level 2

Elevations (Building Elevation)

East

North

South

West

Legends

Schedules/Quantities

Sheets (all)

Families

Groups

Revit Links

Link CAD Formats

Look in: PA1

Nome	Data de modificaç...	Tipo
Nova pasta (2)	09/06/2014 04:13	Pasta de arqui
pa1	10/06/2015 00:22	Arquivo DWG
primeiro andar	07/08/2015 12:24	Arquivo DWG
pro revit	24/10/2015 16:22	Arquivo DWG
segundo andar	18/03/2015 20:37	Arquivo DWG
Terreno	22/07/2015 18:33	Arquivo DWG

File name: primeiro andar

Files of type: DWG Files (*.dwg)

Current view only

Colors: Preserve

Layers/Levels: All

Import units: meter 1.000000

Positioning: Auto - Origin to Origin

Place at: Level 1

Orient to View

Correct lines that are slightly off axis

Tools

Open Cancel

Configurar para a mesma unidade de medida do desenho...abrir...

The image shows the Autodesk Revit 2016 Student Version interface. The ribbon at the top includes tabs for Architecture, Structure, Systems, Insert, Annotate, Analyze, Massing & Site, Collaborate, View, Manage, Add-Ins, and Modify | primeiro andar.dwg. The Properties panel on the left shows the 'Background' property set for the 'primeiro andar.dwg' file. The Project Browser on the left shows the project hierarchy, including Floor Plans (Level 1, Level 2, Site), Ceiling Plans, Elevations, Legends, Schedules/Quantities, Sheets, Families, Groups, and Revit Links. The central view displays a floor plan of Level 1 with a blue highlighted area. A text box at the bottom left reads 'E seu arquivo estará exportado!'.

Properties

Import Symbol
primeiro andar.dwg

primeiro andar.dwg | Edit Type

Dimensions

Instance Scale 1.000000

Identity Data

Name primeiro andar...

Other

Shared Site <Not Shared>

Draw Layer Background

Project Browser - Project1

Views (all)

Floor Plans

- Level 1
- Level 2
- Site

Ceiling Plans

- Level 1
- Level 2

Elevations (Building Elevation)

- East
- North
- South
- West

Legends

Schedules/Quantities

Sheets (all)

Families

Groups

Revit Links


E seu arquivo estará exportado!

1: 100

Click to select, TAB for alternates, CTRL adds, SHIFT unselects.

Main Model

POR 18:31
PTB2 22/11/2015

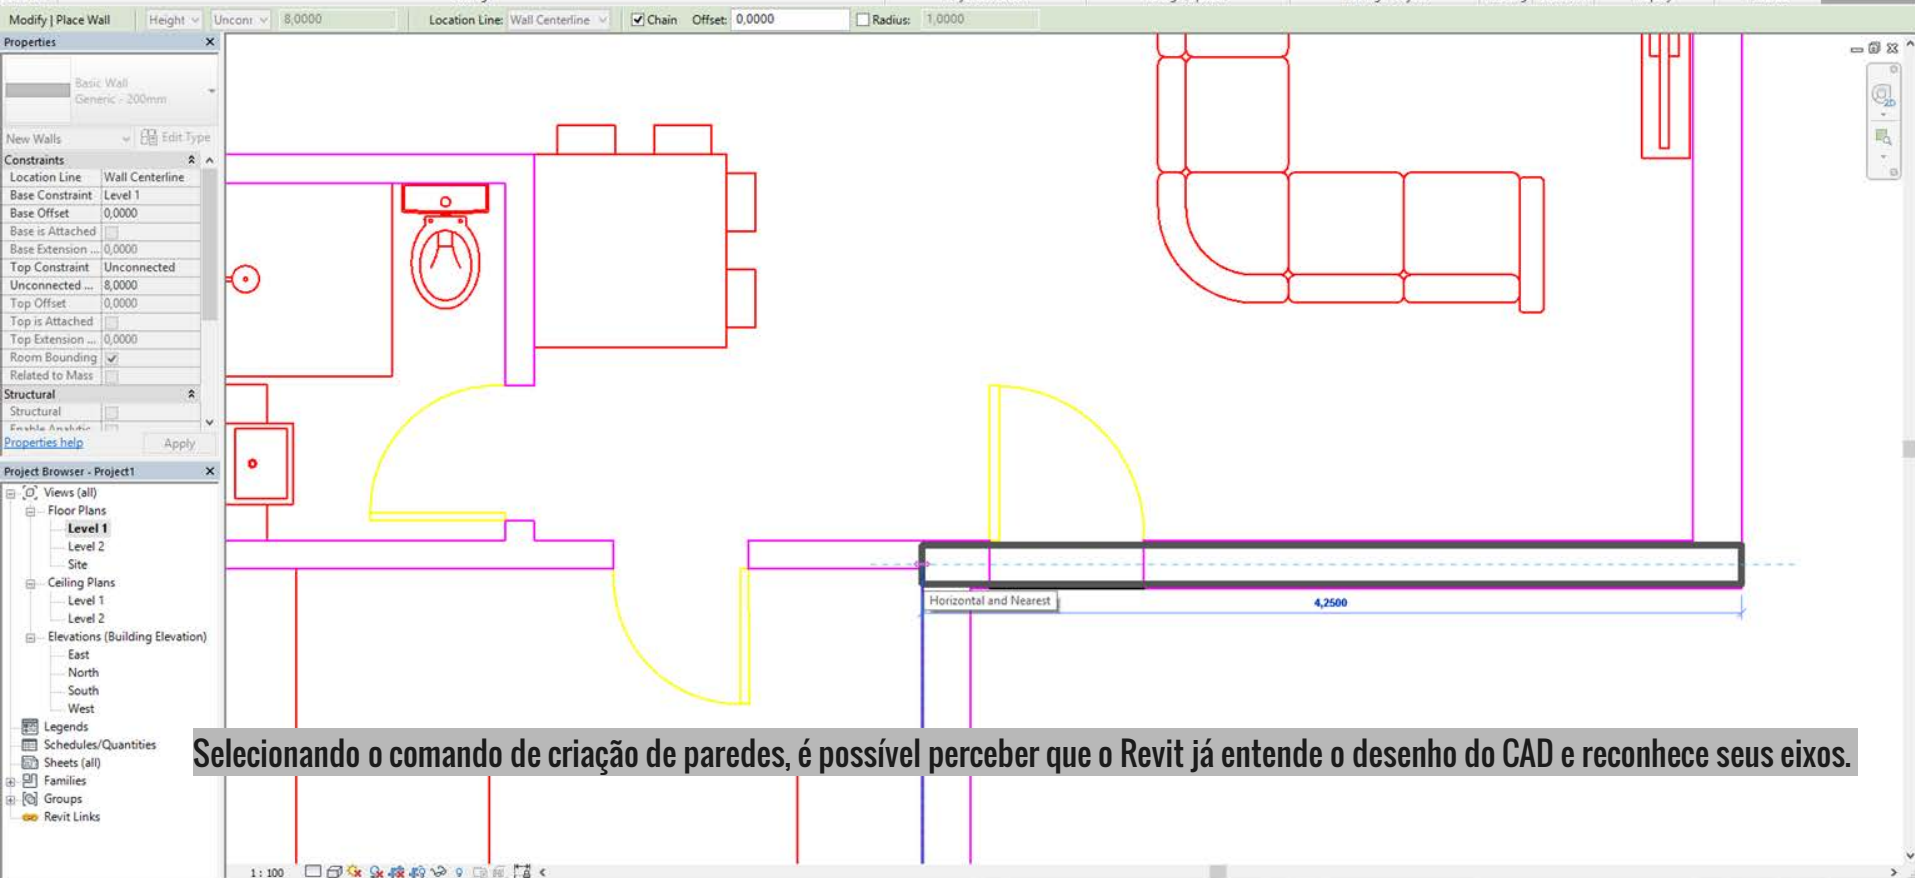

Selecionando o comando de criação de paredes, é possível perceber que o Revit já entende o desenho do CAD e reconhece seus eixos.

Architecture Structure Systems Insert Annotate Analyze Massing & Site Collaborate View Manage Add-Ins Modify | Place Door

Modify | Place Door Horizontal Leader 12,7 mm

Properties

M_Single-Flush
0762 x 2134mm

New Doors Edit Type

Constraints Sill Height 0,0000

Construction Frame Type

Materials and Fini... Frame Material Finish

Identity Data Image Comments Mark

Other Head Height 2,1340

Properties help Apply

Project Browser - Project1


- Views (all)
- Floor Plans
 - Level 1
 - Level 2
 - Site
- Ceiling Plans
 - Level 1
 - Level 2
- Elevations (Building Elevation)
 - East
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- Schedules/Quantities
- Sheets (all)
- Families
- Groups
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Assim como o posicionamento de portas, janelas, etc.

1: 100

Click on Wall to place Door (Space Bar to flip the instance left/right)

Main Model

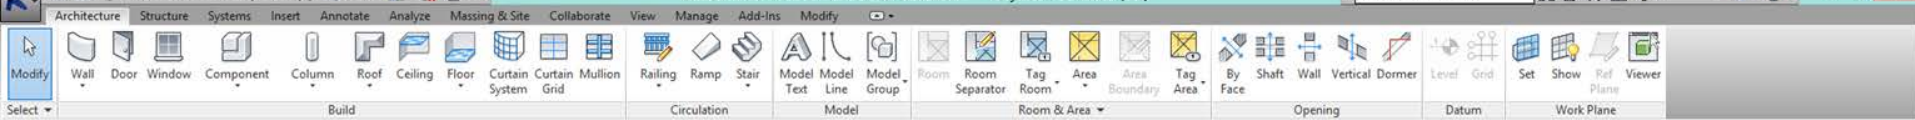

Properties

3D View

3D View: (3D) Edit Type

View Scale: 1 : 100
Scale Value: 1: 100

Detail Level: Medium

Parts Visibility: Show Original

Visibility/Graph... Edit...

Graphic Displa... Edit...

Discipline: Coordination

Show Hidden L... By Discipline

Default Analysi... None

Sun Path:

Extents

Crop View:

Crop Region Vi...:

Annotation Crop:


Far Clip Active:

Far Plane Offset: 3000 mm

Properties help Apply

Project Browser - Project1

- Views (all)
- Floor Plans
 - Level 1
 - Level 2
 - Site
- Ceiling Plans
 - Level 1
 - Level 2
- 3D Views
 - (3D)
- Elevations (Building Elevation)
 - East
 - North
 - South
 - West
- Legends
- Schedules/Quantities
- Sheets (all)
- Families
- Groups
- Revit Links

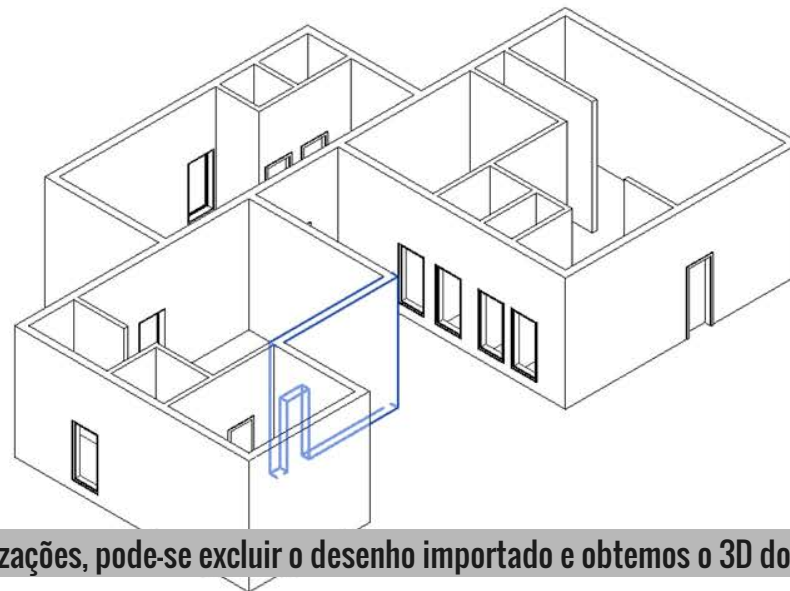

Feito as devidas alterações e utilizações, pode-se excluir o desenho importado e obtemos o 3D do mesmo.